

STORM DRAIN STRUCTURE SCHEDULE COMMENTS LOCATION MODIFIED MD 374.71 W/ CATCH BASIN FILTER 490.50 (SEE FLOW SPLITTER STR. SHEET ?? OF ??) DOUBLE TYPE 'S' COMBINATION 493.67 489.55 489.55 MODULAR WETLAND SYSTEM STRUCTURE - 489.00 489.00 FIELD CONNECTION PIPES 48" MANHOLE 494.15 488.00 485.00 MD-384.01 (48" MH) - 486.00 - END WALL

SWM & STORM DRAIN PIPE SCHEDULE LENGTH 15" ALUMINIZED CMP (12 GA) 27' ±

	LINE TABLE						
LINE#	LENGTH	DIRECTION					
LI	42.67'	S67 [°] 27'15"E					

CURVE DATA							
CURVE#	DELTA	RADIUS	LENGTH	TANGENT	CHORD		
C1	150°46'32"	19.00'	50.00'	72.88'	N33°10'34"E 36.77'		
C2	15°32'14"	254.00'	68.88'	34.62'	S10°42'16"E 68.67'		
C3	62°18'22"	38.00'	41.32'	22.97'	N36°18'04"W 39.32'		

PLANTING NOTES

1. IN THE ABSENCE OF A CONTRACT PROJECT MANUAL CONTAINING PLANTING SPECIFICATIONS, PLANTING PROCEDURES AND MATERIALS SHALL COMPLY WITH THE LANDSCAPE SPECIFICATION GUIDELINES FOR BALTIMORE—WASHINGTON METROPOLITAN AREAS, LATEST EDITION, APPROVED BY THE LANDSCAPE CONTRACTORS ASSOCIATION OF MARYLAND, WASHINGTON AND VIRGINIA Or THE MONTGOMERY COUNTY LANDSCAPE MANUAL, WHICHEVER IS GREATER.

2. PLANT MATERIAL LOCATIONS SHOWN ARE DIAGRAMMATIC AND MAY BE SUBJECT TO CHANGE IN THE FIELD BY THE OWNER'S REPRESENTATIVE.

3. LANDSCAPE PLANTING AND RELATED WORK SHALL BE PERFORMED BY A FIRM WITH A MINIMUM OF FIVE YEARS OF LANDSCAPING EXPERIENCE.

4. DELIVERY OF PLANT MATERIALS SHALL BE FULLY IDENTIFIED WITH THE PLANT NAME AND THE

5. PLANTS SHALL BE PLANTED IN THE MEDIA PROVIDED BY MODULAR WETLANDS INC.

6. PLANTS SHALL BE INSTALLED BETWEEN MARCH 1 AND MAY 31 OR BETWEEN SEPTEMBER 1 AND NOVEMBER 15, UNLESS APPROVED BY OWNER. PLANTS SHALL BE PLANTED ON APPROXIMATE 18"

7. PLANTS SHALL BE SOUND, HEALTHY AND VIGOROUS.

8. CONTRACTOR SHALL WARRANTY THE MATERIALS AND INSTALLATION FOR A PERIOD OF ONE YEAR WARRANTY DURING WHICH THE CONTRACTOR SHALL HAVE RESPONSIBILITY FOR ALL MAINTENANCE OF PLANT MATERIAL AND SOIL MEDIA.

亞 WATER VALVE

FIRE HYDRANT

LEGEND

======== CURB & GUTTER

-O- UTILITY POLE

------- APPROXIMATE BOUNDARY LINE

-//-// TREE PROTECTION FENCE ========== EXISTING STORM DRAIN

= = = = = EXISTING WALL

---- EXISTING WATER MAIN — · — · — · — EXISTING GAS MAIN


————— EXISTING MAJOR CONTUOR EXISTING MINOR CONTOUR

PROPOSED C&G

PROPOSED STORM DRAIN

BRICK PAVERS

HMA PAVING SECTION

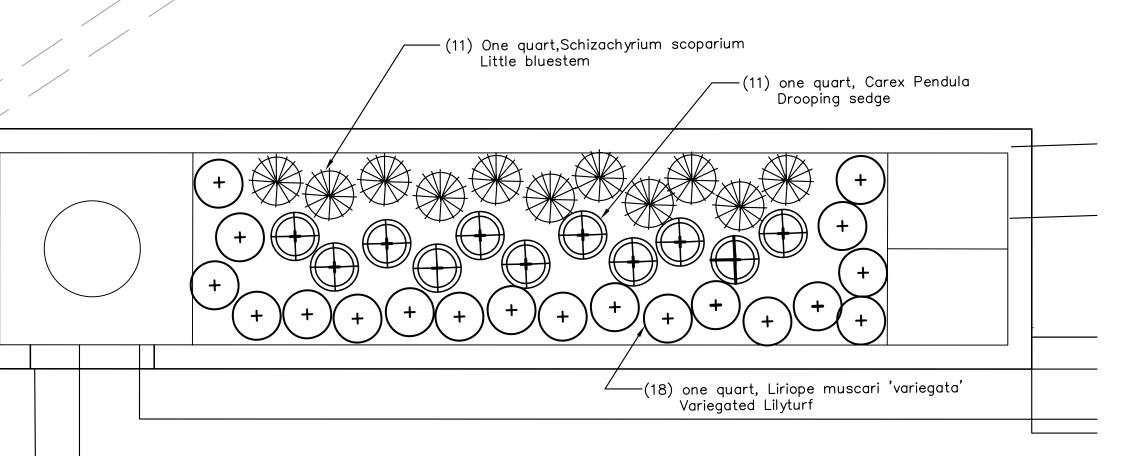

PLANTING PLAN

TAKOMA PARK LINDEN AVE WATER QUALITY RETROFIT & RETAINING WALL REMEDIATION

SITE, GRADING AND UTILITY PLAN



T.E.SCOTT+ASSOCIATES LANDSCAPE | STORMWATER | ENVIRONMENT

128 Cockeysville Road, Ste 200 p: 410.458.2651 Hunt Valley, MD 21030 f: 443.269.0216 tes@mdswm.com www.mdswm.com

Designed By: TES/WRK Scale: AS SHOWN Proj. No. 0901 PROFESSIONAL CERTIFICATION. I HEREBY CERTIFY THAT Date 6/29/09 Drawn By: TAM Checked By: TES SHEET 3 OF 11 LICENSE No. 32602. EXPIRATION DATE: 1-15-2010.

THESE DOCUMENTS WERE PREPARED OR APPROVED BY ME, AND THAT I AM DULY LICENSED PROFESSIONAL ENGINEER UNDER THE LAWS OF THE STATE OF MARYLAND,